


			ro.
STATUS	ISSUED FOR EPA	REV	,12DS
SCALE	1:1000 @ A3	6	Ş
COUNCIL	AUCKLAND COUNCIL	٥	a t
DWG NO	37050-300-DR		Docume

18. ALL RETAINING WALL AND RE WALL DRAINS ARE TO BE 150mmØ SN16
uPVC PIPES, OFFSET 1m FROM THE BOUNDARY AS SHOWN, AT A DEPTH
OF 1.5m.

ALL SW 100mm DIA. RAMPED RISERS ARE TO BE EXTENDED AND CAPPED OFF 1.0m BELOW THE FINISHED GROUND SURFACE AS PER AUCKLAND

FLEXIBLE CONNECTION IS STILL REQUIRED.

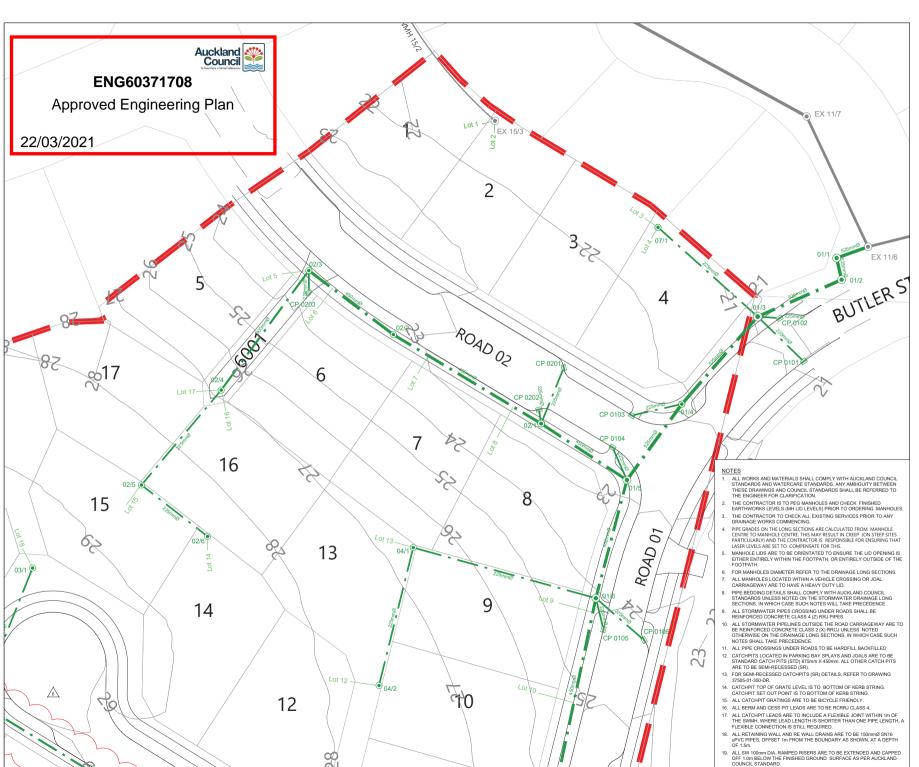



LEGEND

PROPOSED STORMWATER LINE

PROPOSED LOT CONNECTION EXISTING STORMWATER LINE

SITE BOUNDARY

OVERLAND FLOW DIRECTION

MANHOLE PROPOSED

MANHOLE EXISTING

CESSPIT PROPOSED

SCALEBAR (m) SCALE | 1:500 @A3 | 1:250 @A1 | 0 5 10 25

				AN.D
RE	VISION DETAILS	BY	DATE	급
1	ISSUED FOR CONSENT	MB	19/06/20	50,
1	S92 RESPONSE	MRB	18/09/20	E LAY
3	LOA DESIGN CHANGES	MRB	29/10/20	DRAINAGE
6	PIPE SIZES AMENDED	MRB	17/03/21	DRA

SURVEYED	WOODS	25 BANKSIDE ROAD
DESIGNED	MRB	SILVERDALE
DRAWN	MRB	AUCKLAND
CHECKED	MB	
APPROVED	MIZ	WOODS CO N7

ED MS WOODS.CO.N




MILLWATER 25 BANKSIDE ROAD

STORMWATER LAYOUT PLAN SHEET 1

			ΙŽ
STATUS	ISSUED FOR EPA	REV	:\12DS
SCALE	1:500 @ A3	6	So. O
COUNCIL	AUCKLAND COUNCIL	0	
DWG NO	37050-301-DR		Document

cument No. C:\12DSYNERGY\DATA\WP-PEN-APP-01\37050 - BARTLEIT BLOCK.32

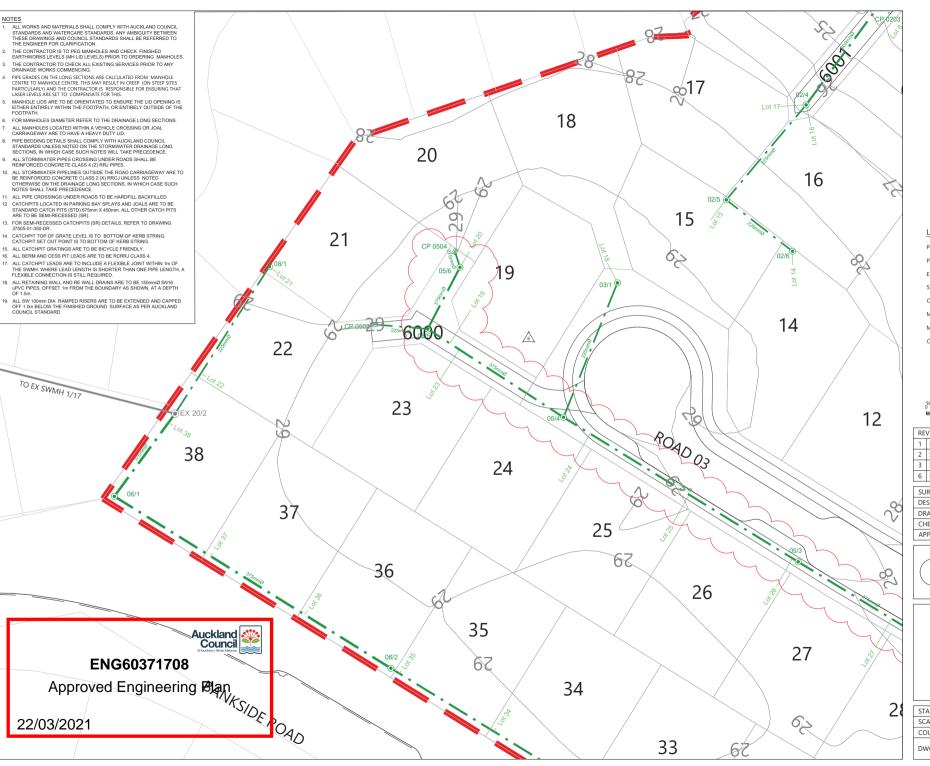



LEGEND

PROPOSED STORMWATER LINE
PROPOSED LOT CONNECTION
EXISTING STORMWATER LINE

SITE BOUNDARY

OVERLAND FLOW DIRECTION

MANHOLE PROPOSED

MANHOLE EXISTING

CESSPIT PROPOSED



SCALEBAR (m) SCALE | 1:500 @A3 | 1:250 @A1 | 0 25

				. Z
RE۱	VISION DETAILS	BY	DATE	LAN.
1	ISSUED FOR CONSENT	MB	19/06/20	5
2	S92 RESPONSE	MRB	18/09/20	E LA
3	LOA DESIGN CHANGES	MRB	29/10/20	DRAINAGE
6	PIPE SIZES AMENDED	MRB	17/03/21	2 DRA
	1 2 3	2 S92 RESPONSE 3 LOA DESIGN CHANGES	1 ISSUED FOR CONSENT MB 2 S92 RESPONSE MRB 3 LOA DESIGN CHANGES MRB	1 ISSUED FOR CONSENT MB 19/06/20 2 S92 RESPONSE MRB 18/09/20 3 LOA DESIGN CHANGES MRB 29/10/20


SURVEYED	WOODS	25 BANKSIDE ROAD
DESIGNED	MRB	SILVERDALE
DRAWN	MRB	AUCKLAND
CHECKED	MB	
APPROVED	MR	WOODS CO N7



MILLWATER 25 BANKSIDE ROAD

STORMWATER LAYOUT PLAN SHEET 2

			. ⋩
STATUS	ISSUED FOR EPA	REV	12D
SCALE	1:500 @ A3	6	Ş.
COUNCIL	AUCKLAND COUNCIL	О	ž
DWG NO	37050-302-DR		Docume

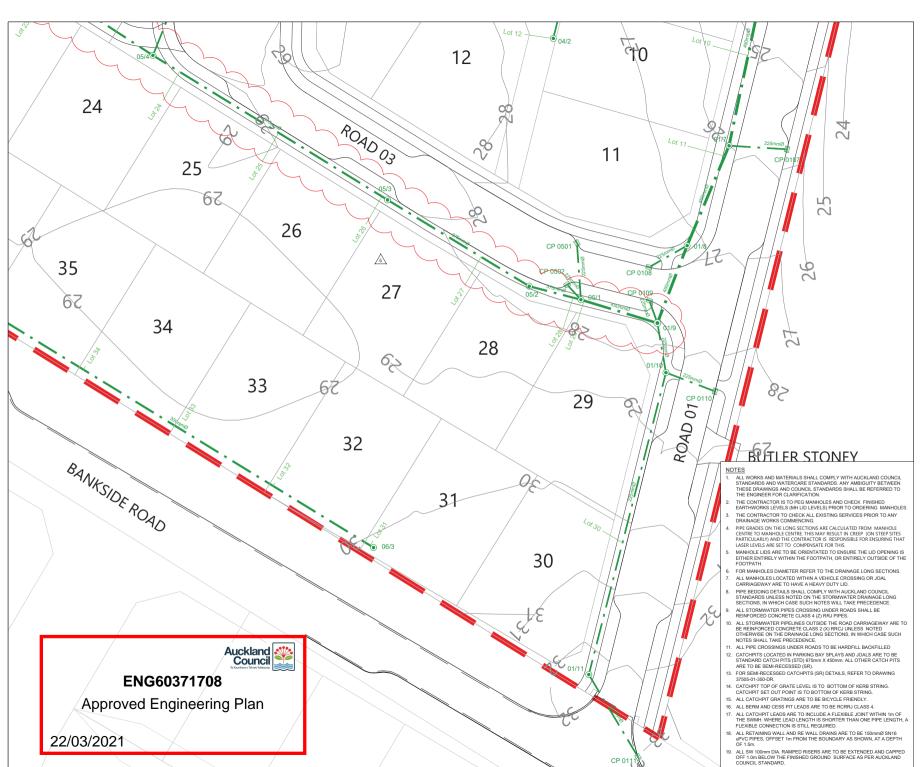



LEGEND

PROPOSED STORMWATER LINE

PROPOSED LOT CONNECTION

EXISTING STORMWATER LINE

OVERLAND FLOW DIRECTION

MANHOLE PROPOSED

SITE BOLINDARY

MANHOLF EXISTING

CESSPIT PROPOSED

SCALE | 1:500 @A3 | 1:250 @A1|

REVISION DETAILS DATE BY ISSUED FOR CONSENT МВ 19/06/20 S92 RESPONSE MRB 18/09/20 LOA DESIGN CHANGES MRB 29/10/20 6 PIPE SIZES AMENDED MRB 17/03/21

SURVEYED	WOODS	25 BANKSIDE ROAD
DESIGNED	MRB	SILVERDALE
DRAWN	MRB	AUCKLAND
CHECKED	MB	
APPROVED	MR	WOODS.CO.NZ





MILLWATER 25 BANKSIDE ROAD

STORMWATER LAYOUT PLAN SHEET 3

STATUS	ISSUED FOR EPA	REV	12DSYI
SCALE	1:500 @ A3	6	ζ. C.
COUNCIL	AUCKLAND COUNCIL	О	ment N
DWG NO	37050-303-DR		Docum

1 FOR TENDER

3 LONGSECTIONS UPDATED

2 FOR EPA

MRB

MRB

MRB

10/11/20

03/02/21

24/02/21

DESIGNED

DRAWN

CHECKED

APPROVED

MRB

MRB

MB

THIS PREFERRED SAFE TRENCHING SOLUTION DOES NOT APPLY WHEN TRENCHING IN COMPLEX GROUND

ALL TRENCH EXCAVATIONS IN COMPLEX GROUND CONDITIONS MUST BE ASSESSED BY AN 'EXPERIENCED TEMPORARY WORKS DESIGNER' IN ACCORDANCE WITH THE WORKSAFE GUIDELINES FOR EXCAVATION SAFETY.

PREFERRED SAFE TRENCHING SOLUTION IN NORMAL GROUND CONDITIONS



25 BANKSIDE ROAD

SII VERDALE

WOODS.CO.NZ

WFH }

SAFE TRENCHING NOTES:

- THIS DIAGRAM SHOWS THE DREEEDED SAFE TRENCHING SOLUTION IN NORMAL GROUND CONDITIONS
- ALL TRENCH EXCAVATIONS MUST BE ASSESSED BY A 'COMPETENT PERSON' ON SITE IN ACCORDANCE WITH THE WORKSAFE GUIDELINES FOR EXCAVATION SAFETY
- . IF THE PREFERRED TRENCHING SOLUTION IS NOT IMPLEMENTED THE CONTRACTOR MUST PROVIDE RECORDS OF THE SAFE TRENCHING ASSESSMENT COMPLETED BY THE 'COMPETENT PERSON'.

 4. TABLES 1 AND 2 OF THE WORKSAFE GUIDELINES SETOUT THE RECOMMENDED COMPETENCIES FOR THE
- 'COMPETENT PERSON'. TABLES 1 & 2 ARE INCLUDED IN THE CONTRACT DOCUMENTS.
 GROUND CONDITIONS AS DEFINED IN TABLES 1 AND 2 OF THE WORKSAFE GUILDELINES:
- NORMAL GROUND CONDITIONS:
 GENERALLY FLAT OPEN GROUND, WITH LITTLE OR NO SURCHARGE LOADING, FAVOURABLE GROUND CONDITIONS, OFF SET FROM NEARBY STRUCTURES AND SENSITIVE INFRASTRUCTURE. GROUNDWATER CAN BE CONTROLLED WITH SIMPLE METHODS, SUCH AS A SUMP PUMP ARRAGEMENT
- THE GROUND CONDITIONS INCLUDE VERY WEAK OR SENSITIVE SOILS, GROUNDWATER THAT REQUIRES
 SPECIALIST DEWATERING, OR LOCATIONS NEAR STRUCTURES AND SENSITIVE INFRASTRUCTURE. THESE

- 1. ALL WORKS AND MATERIALS TO COMPLY WITH AUCKLAND COUNCIL STANDARDS AND WATERCARE STANDARDS.
- ALL SW AND SW 100mm DIA. RAMPED RISERS ARE TO BE EXTENDED AND CAPPED OFF 1.0m
- 3. THE CONTRACTOR IS TO PEG MANHOLES AND CHECK FINISHED EARTHWORKS LEVELS (MH LID
- 4. PIPE GRADES ON THE LONG SECTIONS ARE CALCULATED FROM MANHOLE CENTRE TO MANHOLE CENTRE. THIS MAY RESULT IN CREEP (ON STEEP SITES PARTICULARLY) AND THE CONTRACTOR IS RESPONSIBLE FOR ENSURING THAT LASER LEVELS ARE SET TO COMPENSATE FOR THIS.

LEGEND

SCALE

COUNCIL


AS SHOWN

AUCKLAND COUNCIL

37050-320-DR

3



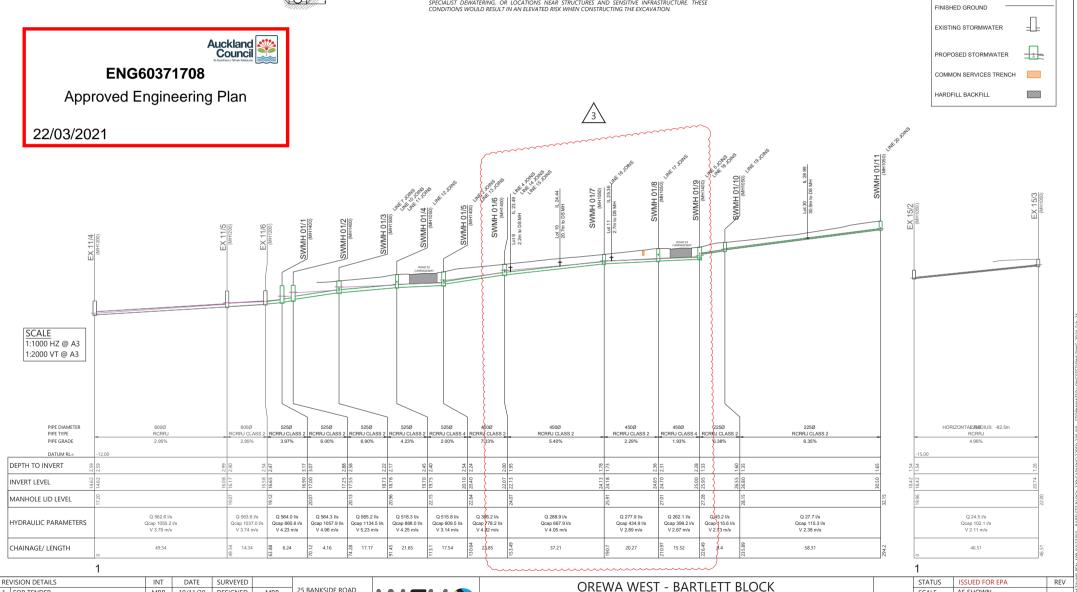

STORMWATER LONGSECTIONS

SHEET 1 OF 5

THIS PREFERRED SAFE TRENCHING SOLUTION DOES NOT APPLY WHEN TRENCHING IN COMPLEX GROUND

ALL TRENCH EXCAVATIONS IN COMPLEX GROUND CONDITIONS MUST BE ASSESSED BY AN 'EXPERIENCED TEMPORARY WORKS DESIGNER' IN ACCORDANCE WITH THE WORKSAFE GUIDELINES FOR EXCAVATION SAFETY.

PREFERRED SAFE TRENCHING SOLUTION IN NORMAL GROUND CONDITIONS



Auckland Council

ENG60371708

Approved Engineering Plan

SAFE TRENCHING NOTES:

- THIS DIAGRAM SHOWS THE DREEEDED SAFE TRENCHING SOLUTION IN NORMAL GROUND CONDITIONS
- ALL TRENCH EXCAVATIONS MUST BE ASSESSED BY A 'COMPETENT PERSON' ON SITE IN ACCORDANCE WITH THE WORKSAFE GUIDELINES FOR EXCAVATION SAFETY
- 3. IF THE PREFERRED TRENCHING SOLUTION IS NOT IMPLEMENTED THE CONTRACTOR MUST PROVIDE
- RECORDS OF THE SAFE TRENCHING ASSESSMENT COMPLETED BY THE 'COMPETENT PERSON'.


 4. TABLES 1 AND 2 OF THE WORKSAFE GUIDELINES SETOUT THE RECOMMENDED COMPETENCIES FOR THE
- 'COMPETENT PERSON'. TABLES 1 & 2 ARE INCLUDED IN THE CONTRACT DOCUMENTS.
 GROUND CONDITIONS AS DEFINED IN TABLES 1 AND 2 OF THE WORKSAFE GUILDELINES:
- NORMAL GROUND CONDITIONS:
 GENERALLY FLAT OPEN GROUND, WITH LITTLE OR NO SURCHARGE LOADING, FAVOURABLE GROUND. GENERALET FOR OPEN GROUND, WITH LITTLE OF NO SOCIETARIAGE LOADING, PAYOURABLE GROUND CONDITIONS, OFF SET FROM NEARBY STRUCTURES AND SENSITIVE INFRASTRUCTURE. GROUNDWATER CAN BE CONTROLLED WITH SIMPLE METHODS, SUCH AS A SUMP PUMP ARRAGEMENT.
- THE GROUND CONDITIONS INCLUDE VERY WEAK OR SENSITIVE SOILS, GROUNDWATER THAT REQUIRES
 SPECIALIST DEWATERING. OR LOCATIONS NEAR STRUCTURES AND SENSITIVE INFRASTRUCTURE. THESE CONDITIONS WOULD RESULT IN AN FLEVATED RISK WHEN CONSTRUCTING THE EXCAVATION


- 1. ALL WORKS AND MATERIALS TO COMPLY WITH AUCKLAND COUNCIL STANDARDS AND
- WATERCARE STANDARDS.


 2. ALL SW AND SW 100mm DIA. RAMPED RISERS ARE TO BE EXTENDED AND CAPPED OFF 1.0m
- 3. THE CONTRACTOR IS TO PEG MANHOLES AND CHECK FINISHED EARTHWORKS LEVELS (MH LID
- 4. PIPE GRADES ON THE LONG SECTIONS ARE CALCULATED FROM MANHOLE CENTRE TO MANHOLE CENTRE. THIS MAY RESULT IN CREEP (ON STEEP SITES PARTICULARLY) AND THE CONTRACTOR IS RESPONSIBLE FOR ENSURING THAT LASER LEVELS ARE SET TO COMPENSATE FOR THIS.





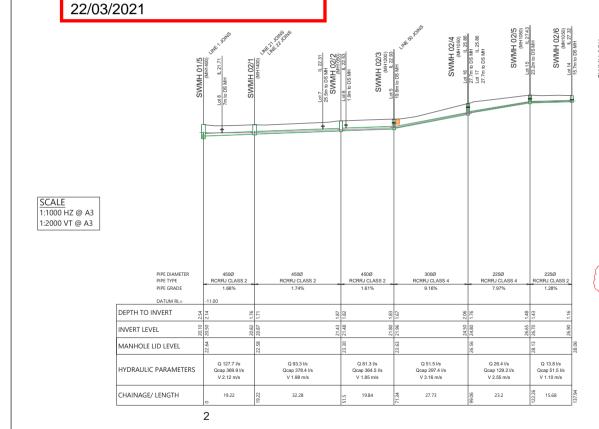

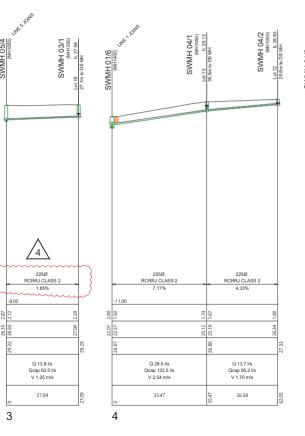

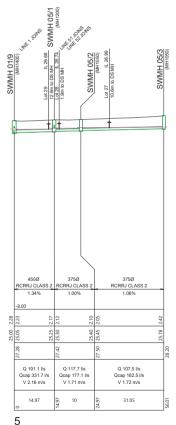

RE	VISION DETAILS	INT	DATE	SURVEYED		
1	FOR TENDER	MRB	10/11/20	DESIGNED	MRB	25 BANKSIDE ROAD SII VERDALE
2	FOR EPA	MRB	03/02/21	DRAWN	MRB	SILVERDALE
3	LONGSECTIONS UPDATED	MRB	24/02/21	CHECKED	MB	
4	PIPE CLASS AMENDMENTS	MRB	12/03/21	APPROVED	MB	WOODS.CO.NZ



OREWA WEST - BARTLETT BLOCK

STORMWATER LONGSECTIONS	
SHEET 2 OF 5	

			ġ.
STATUS	ISSUED FOR EPA	REV	8
SCALE	AS SHOWN	4	VP.
COUNCIL	AUCKLAND COUNCIL	4	ERG
DWG NO	37050-321-DR		N12DSYN

THIS PREFERRED SAFE TRENCHING SOLUTION DOES NOT APPLY WHEN TRENCHING IN COMPLEX GROUND

ALL TRENCH EXCAVATIONS IN COMPLEX GROUND CONDITIONS MUST BE ASSESSED BY AN 'EXPERIENCED TEMPORARY WORKS DESIGNER' IN ACCORDANCE WITH THE WORKSAFE GUIDELINES FOR EXCAVATION SAFETY.

ENG60371708

Approved Engineering Plan

PREFERRED SAFE TRENCHING SOLUTION IN NORMAL GROUND CONDITIONS



SAFE TRENCHING NOTES:

- THIS DIAGRAM SHOWS THE DREEPRED SAFE TRENCHING SOLUTION IN NORMAL GROUND CONDITIONS
- ALL TRENCH EXCAVATIONS MUST BE ASSESSED BY A 'COMPETENT PERSON' ON SITE IN ACCORDANCE WITH THE WORKSAFE GUIDELINES FOR EXCAVATION SAFETY
- 3. IF THE PREFERRED TRENCHING SOLUTION IS NOT IMPLEMENTED THE CONTRACTOR MUST PROVIDE RECORDS OF THE SAFE TRENCHING ASSESSMENT COMPLETED BY THE 'COMPETENT PERSON'.

 4. TABLES 1 AND 2 OF THE WORKSAFE GUIDELINES SETOUT THE RECOMMENDED COMPETENCIES FOR THE
- 'COMPETENT PERSON'. TABLES 1 & 2 ARE INCLUDED IN THE CONTRACT DOCUMENTS.
 GROUND CONDITIONS AS DEFINED IN TABLES 1 AND 2 OF THE WORKSAFE GUILDELINES:


- NORMAL GROUND CONDITIONS:
 GENERALLY FLAT OPEN GROUND, WITH LITTLE OR NO SURCHARGE LOADING, FAVOURABLE GROUND. CONDITIONS, OFF SET FROM NEARBY STRUCTURES AND SENSITIVE INFRASTRUCTURE. GROUNDWATER CAN BE CONTROLLED WITH SIMPLE METHODS, SUCH AS A SUMP PUMP ARRAGEMENT
- BECUNITIOLLED WITH SIMPLE METHOUS, SUCH AS A SUMP POINT ARRAGEMENT.
 COMPLEX ROOUND CONDITIONS TO THE REPORT OF THE REPORT OF THE REQUIRES SPECIALIST DEWATERING, OR LOCATIONS NEAR STRUCTURES AND SENSITIVE INFRASTRUCTURE. THESE
 SPECIALIST DEWATERING, OR LOCATIONS NEAR STRUCTURES AND SENSITIVE INFRASTRUCTURE. THESE CONDITIONS WOULD RESULT IN AN FLEVATED RISK WHEN CONSTRUCTING THE EXCAVATION

- 1. ALL WORKS AND MATERIALS TO COMPLY WITH AUCKLAND COUNCIL STANDARDS AND
- WATERCARE STANDARDS.


 2. ALL SW AND SW 100mm DIA. RAMPED RISERS ARE TO BE EXTENDED AND CAPPED OFF 1.0m
- 3. THE CONTRACTOR IS TO PEG MANHOLES AND CHECK FINISHED EARTHWORKS LEVELS (MH LID
- 4. PIPE GRADES ON THE LONG SECTIONS ARE CALCULATED FROM MANHOLE CENTRE TO MANHOLE CENTRE. THIS MAY RESULT IN CREEP (ON STEEP SITES PARTICULARLY) AND THE CONTRACTOR IS RESPONSIBLE FOR ENSURING THAT LASER LEVELS ARE SET TO COMPENSATE FOR THIS.



LEGEND FINISHED GROUND EXISTING STORMWATER PROPOSED STORMWATER COMMON SERVICES TRENCH HARDFILL BACKFILL

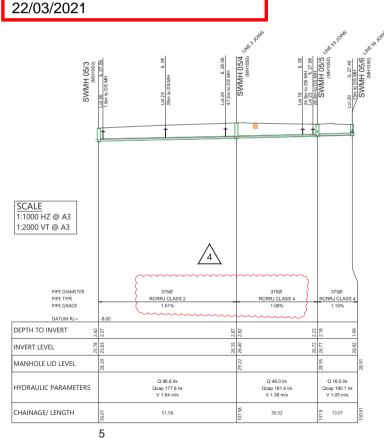

Auckland Council

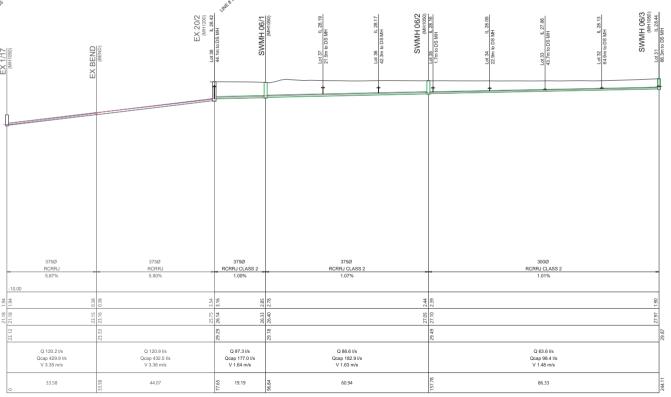

REVISION DETAILS DATE SURVEYED 25 BANKSIDE ROAD 1 FOR TENDER MRB 10/11/20 DESIGNED MRB SII VERDALE 2 FOR EPA MRB MRB 03/02/21 DRAWN 3 LONGSECTIONS UPDATED MRB 24/02/21 CHECKED 4 PIPE CLASS AMENDMENTS MRB 12/03/21 APPROVED MR WOODS.CO.NZ



6

OREWA WEST - BARTLETT BLOCK

STORMWATER LONGSECTIONS SHEET 3 OF 5

			غوا
STATUS	ISSUED FOR EPA	REV	ĮŠ.
SCALE	AS SHOWN	1	Ş.
COUNCIL	AUCKLAND COUNCIL	4	ERG
DWG NO	37050-322-DR		N12DSYN

THIS PREFERRED SAFE TRENCHING SOLUTION DOES NOT APPLY WHEN TRENCHING IN COMPLEX GROUND

ALL TRENCH EXCAVATIONS IN COMPLEX GROUND CONDITIONS MUST BE ASSESSED BY AN 'EXPERIENCED TEMPORARY WORKS DESIGNER' IN ACCORDANCE WITH THE WORKSAFE GUIDELINES FOR EXCAVATION SAFETY.

22/03/2021

PREFERRED SAFE TRENCHING SOLUTION IN NORMAL GROUND CONDITIONS



Auckland 4 Council

ENG60371708

Approved Engineering Plan

SAFE TRENCHING NOTES:

- THIS DIAGRAM SHOWS THE DREEEDED SAFE TRENCHING SOLUTION IN NORMAL GROUND CONDITIONS
- ALL TRENCH EXCAVATIONS MUST BE ASSESSED BY A 'COMPETENT PERSON' ON SITE IN ACCORDANCE WITH THE WORKSAFE GUIDELINES FOR EXCAVATION SAFETY
- . IF THE PREFERRED TRENCHING SOLUTION IS NOT IMPLEMENTED THE CONTRACTOR MUST PROVIDE RECORDS OF THE SAFE TRENCHING ASSESSMENT COMPLETED BY THE 'COMPETENT PERSON'.


 4. TABLES 1 AND 2 OF THE WORKSAFE GUIDELINES SETOUT THE RECOMMENDED COMPETENCIES FOR THE
- 'COMPETENT PERSON'. TABLES 1 & 2 ARE INCLUDED IN THE CONTRACT DOCUMENTS.
 GROUND CONDITIONS AS DEFINED IN TABLES 1 AND 2 OF THE WORKSAFE GUILDELINES:
- NORMAL GROUND CONDITIONS:
 GENERALLY FLAT OPEN GROUND, WITH LITTLE OR NO SURCHARGE LOADING, FAVOURABLE GROUND. CONDITIONS, OFF SET FROM NEARBY STRUCTURES AND SENSITIVE INFRASTRUCTURE. GROUNDWATER CAN BE CONTROLLED WITH SIMPLE METHODS, SUCH AS A SUMP PUMP ARRAGEMENT.
- THE GROUND CONDITIONS INCLUDE VERY WEAK OR SENSITIVE SOILS, GROUNDWATER THAT REQUIRES
 SPECIALIST DEWATERING, OR LOCATIONS NEAR STRUCTURES AND SENSITIVE INFRASTRUCTURE. THESE

- 1. ALL WORKS AND MATERIALS TO COMPLY WITH AUCKLAND COUNCIL STANDARDS AND
- WATERCARE STANDARDS.

 2. ALL SW AND SW 100mm DIA. RAMPED RISERS ARE TO BE EXTENDED AND CAPPED OFF 1.0m
- 3 THE CONTRACTOR IS TO PEG MANHOLES AND CHECK FINISHED FARTHWORKS LEVELS (MH LID
- 4. PIPE GRADES ON THE LONG SECTIONS ARE CALCULATED FROM MANHOLF CENTRE TO MANHOLF CENTRE. THIS MAY RESULT IN CREEP (ON STEEP SITES PARTICULARLY) AND THE CONTRACTOR IS RESPONSIBLE FOR ENSURING THAT LASER LEVELS ARE SET TO COMPENSATE FOR THIS.





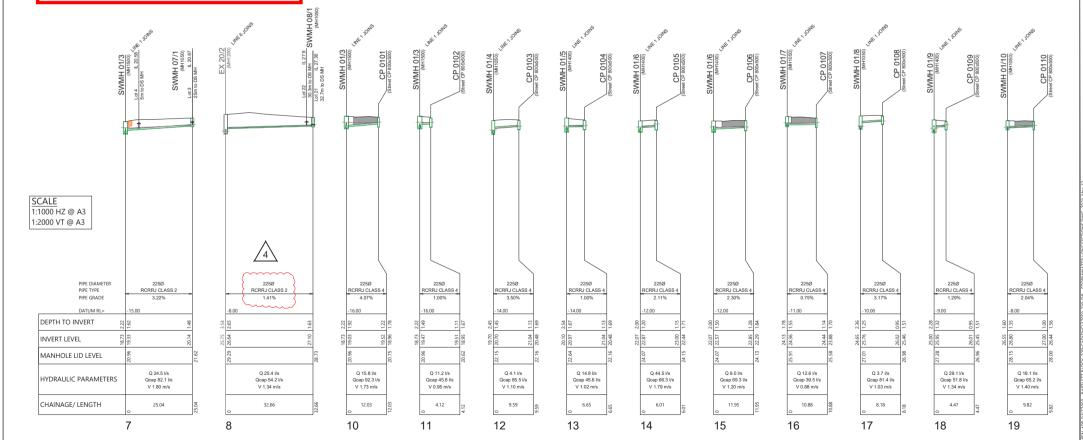

REVISION DETAILS		INT	DATE	SURVEYED			
	1	FOR TENDER	MRB	10/11/20	DESIGNED	MRB	25 BANKSIDE ROAD SILVERDALE
	2	FOR EPA	MRB	03/02/21	DRAWN	MRB	SILVERDALE
	3	LONGSECTIONS UPDATED	MRB	24/02/21	CHECKED	MB	
	4	PIPE CLASS AMENDMENTS	MRB	12/03/21	APPROVED	MB	WOODS.CO.NZ



OREWA WEST - BARTLETT BLOCK

STORMWATER LONGSECTIONS	
SHEET 4 OF 5	

			غوا
STATUS	ISSUED FOR EPA	REV	ĮŠ.
SCALE	AS SHOWN	1	Ş.
COUNCIL	AUCKLAND COUNCIL	4	ERG
DWG NO	37050-323-DR		N12DSYN

THIS PREFERRED SAFE TRENCHING SOLUTION DOES NOT APPLY WHEN TRENCHING IN COMPLEX GROUND

ALL TRENCH EXCAVATIONS IN COMPLEX GROUND CONDITIONS MUST BE ASSESSED BY AN 'EXPERIENCED TEMPORARY WORKS DESIGNER' IN ACCORDANCE WITH THE WORKSAFE GUIDELINES FOR EXCAVATION SAFETY.

PREFERRED SAFE TRENCHING SOLUTION IN NORMAL GROUND CONDITIONS



SAFE TRENCHING NOTES:


- THIS DIAGRAM SHOWS THE DREEEDED SAFE TRENCHING SOLUTION IN NORMAL GROUND CONDITIONS
- ALL TRENCH EXCAVATIONS MUST BE ASSESSED BY A 'COMPETENT PERSON' ON SITE IN ACCORDANCE WITH THE WORKSAFE GUIDELINES FOR EXCAVATION SAFETY
- 3. IF THE PREFERRED TRENCHING SOLUTION IS NOT IMPLEMENTED THE CONTRACTOR MUST PROVIDE RECORDS OF THE SAFE TRENCHING ASSESSMENT COMPLETED BY THE 'COMPETENT PERSON'.

 4. TABLES 1 AND 2 OF THE WORKSAFE GUIDELINES SETOUT THE RECOMMENDED COMPETENCIES FOR THE
- 'COMPETENT PERSON'. TABLES 1 & 2 ARE INCLUDED IN THE CONTRACT DOCUMENTS.
 GROUND CONDITIONS AS DEFINED IN TABLES 1 AND 2 OF THE WORKSAFE GUILDELINES:
- NORMAL GROUND CONDITIONS:
 GENERALLY FLAT OPEN GROUND, WITH LITTLE OR NO SURCHARGE LOADING, FAVOURABLE GROUND. CONDITIONS, OFF SET FROM NEARBY STRUCTURES AND SENSITIVE INFRASTRUCTURE. GROUNDWATER CAN BE CONTROLLED WITH SIMPLE METHODS, SUCH AS A SUMP PUMP ARRAGEMENT
- BECUNITIOLLED WITH SIMPLE METHOUS, SUCH AS A SUMP POINT ARRAGEMENT.
 COMPLEX ROOUND CONDITIONS TO THE REPORT OF THE REPORT OF THE REQUIRES SPECIALIST DEWATERING, OR LOCATIONS NEAR STRUCTURES AND SENSITIVE INFRASTRUCTURE. THESE
 SPECIALIST DEWATERING, OR LOCATIONS NEAR STRUCTURES AND SENSITIVE INFRASTRUCTURE. THESE CONDITIONS WOULD RESULT IN AN FLEVATED RISK WHEN CONSTRUCTING THE EXCAVATION

- 1. ALL WORKS AND MATERIALS TO COMPLY WITH AUCKLAND COUNCIL STANDARDS AND
- WATERCARE STANDARDS.

 2. ALL SW AND SW 100mm DIA. RAMPED RISERS ARE TO BE EXTENDED AND CAPPED OFF 1.0m
- 3 THE CONTRACTOR IS TO PEG MANHOLES AND CHECK FINISHED FARTHWORKS LEVELS (MH LID
- 4. PIPE GRADES ON THE LONG SECTIONS ARE CALCULATED FROM MANHOLE CENTRE TO MANHOLE CENTRE. THIS MAY RESULT IN CREEP (ON STEEP SITES PARTICULARLY) AND THE CONTRACTOR IS RESPONSIBLE FOR ENSURING THAT LASER LEVELS ARE SET TO COMPENSATE FOR THIS.



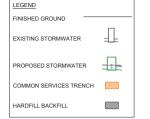



ENG60371708

Approved Engineering Plan

22/03/2021

SCALE 1:1000 HZ @ A3 1:2000 VT @ A3

REVISION DETAILS

3 LONGSECTIONS UPDATED

1 FOR TENDER

2 FOR EPA

PIPE DIAMETER PIPE GRADE

DEPTH TO INVERT INVERT LEVEL

MANHOLE LID LEVEL

CHAINAGE/ LENGTH

MRB

MRB

MB

DATE

10/11/20

03/02/21

24/02/21

MRB

MRB

MRB

SURVEYED

DESIGNED

DRAWN

CHECKED

APPROVED

HYDRAULIC PARAMETERS

25 BANKSIDE ROAD SILVERDALE	WFH(
WOODS.CO.NZ	


225Ø

2.23%

Qcap 68.2 l/s

V 1.38 m/s


20

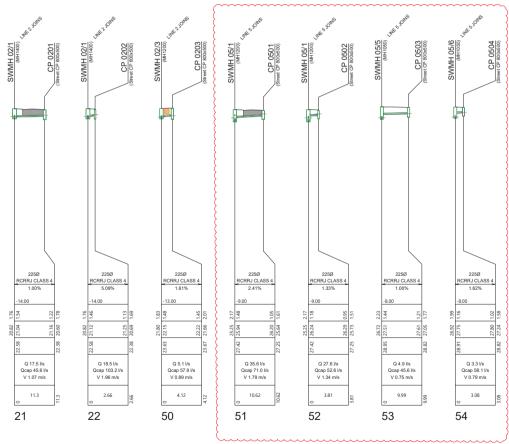

OREWA WEST - BARTLETT BLOCK

STORMWATER LONGSECTIONS SHEET 5 OF 5

STATUS	ISSUED FOR EPA	REV
SCALE	AS SHOWN	2
COUNCIL	AUCKLAND COUNCIL	3
DWG NO	37050-324-DR	

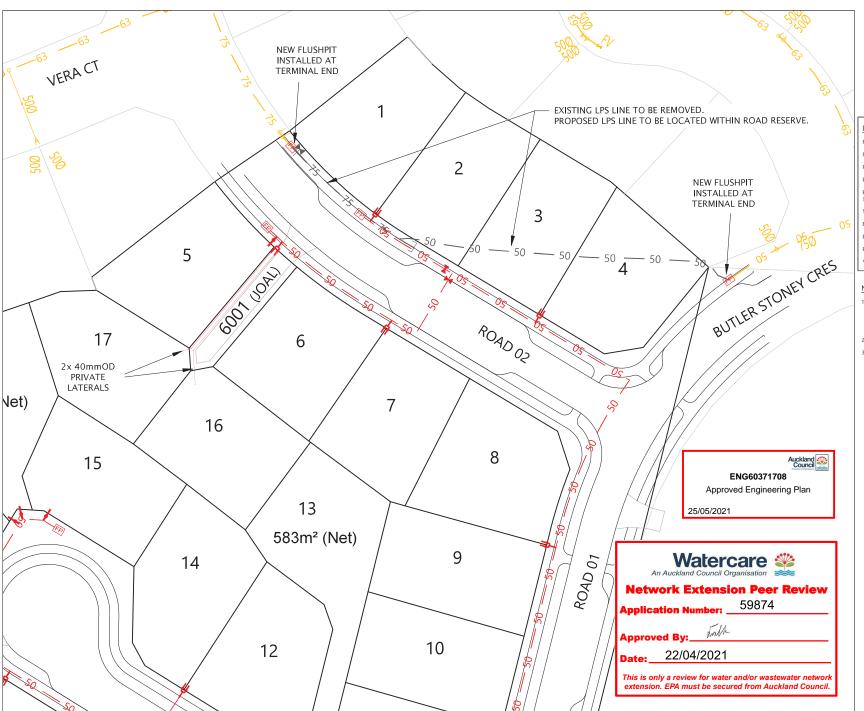



LEGEND	
PROPOSED LPS LINE - 63mmOD	6363
PROPOSED LPS LINE - 50mmOD	— 50 — 50 —
PROPOSED LPS LINE - 40mmOD	
EXISTING LPS LINE	
EXISTING LPS LINE (TO BE REMOVED)	— 50 — 50 —
SITE BOUNDARY	
BOUNDARY KIT - DOUBLE	- #=
BOUNDARY KIT - SINGLE	-
FLUSH PIT	FP
VALVE	H

NOTES

- ALL WORKS AND MATERIALS SHALL COMPLY WITH AUCKLAND COUNCIL STANDARDS FOR ENGINEERING DESIGN AND CONSTRUCTION, ANY MANIGUTY BETWEEN THESE DRAWINGS AND COUNCIL STANDARDS ARE TO BE REFERRED TO ENGINEER FOR CLARRICATION.
- 2. ALL PIPE CROSSINGS UNDER ROADS TO BE HARDFILL BACKFILLED.
- 3. ALL LOW PRESSURE SANITARY SEWER PIPES SHALL BE SDR 11, PE100 PN16.

SCALE | 1:500 @A3 | 1:250 @A1| REVISION DETAILS BY DATE 1 | ISSUED FOR EPA MRB 09/03/21


SURVEYED	WOODS	25 BANKSIDE ROAD	FWAT
DESIGNED	MB	SILVERDALE	WASTE
DRAWN	MRB	AUCKLAND	1.3
CHECKED	MS		an-nob
APPROVED	MR	WOODS CO NZ	13





MILLWATER 25 BANKSIDE ROAD

WASTEWATER DRAINAGE LAYOUT PLAN SHEET 1

STATUS	ISSUED FOR EPA	REV	CV120S
SCALE	1:500 @ A3	1	Û.
COUNCIL	AUCKLAND COUNCIL	7 '	ant R
DWG NO	37050-401-DR		Docume

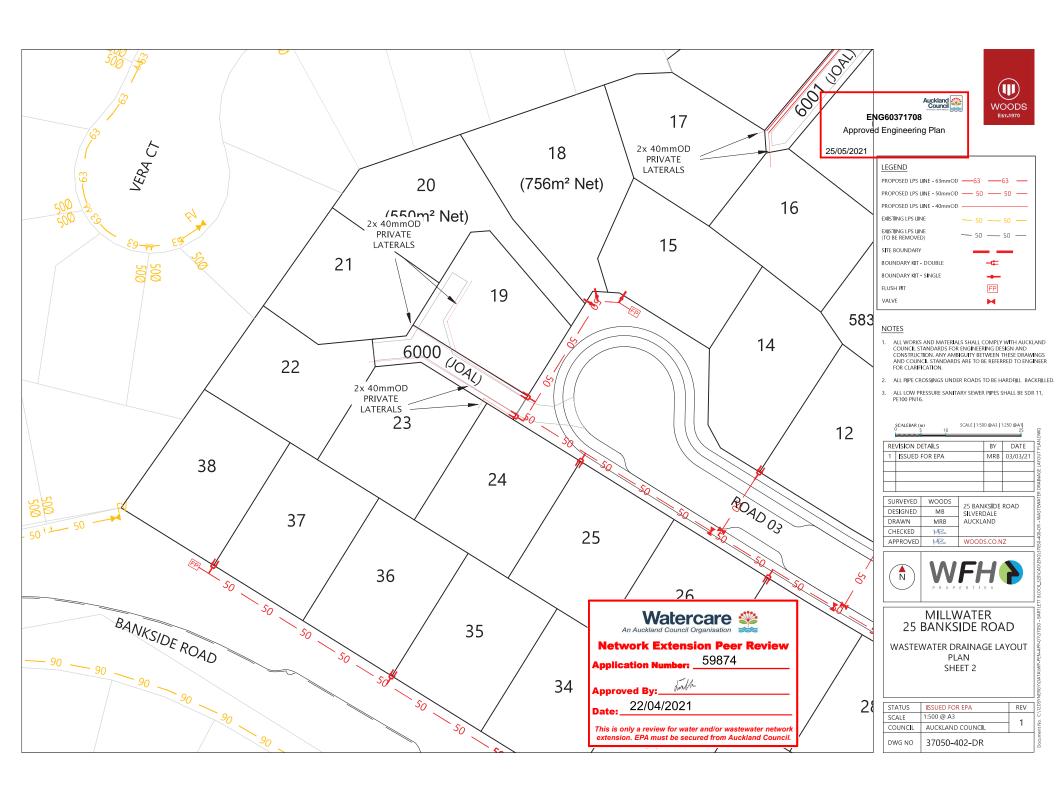

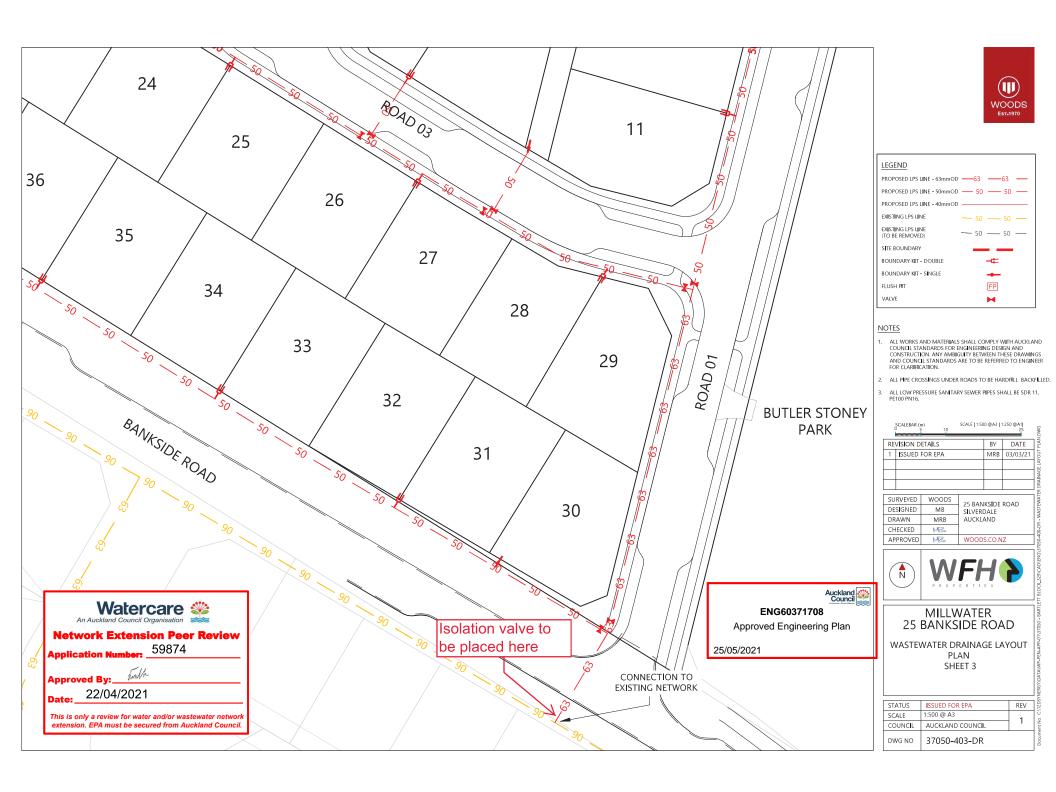

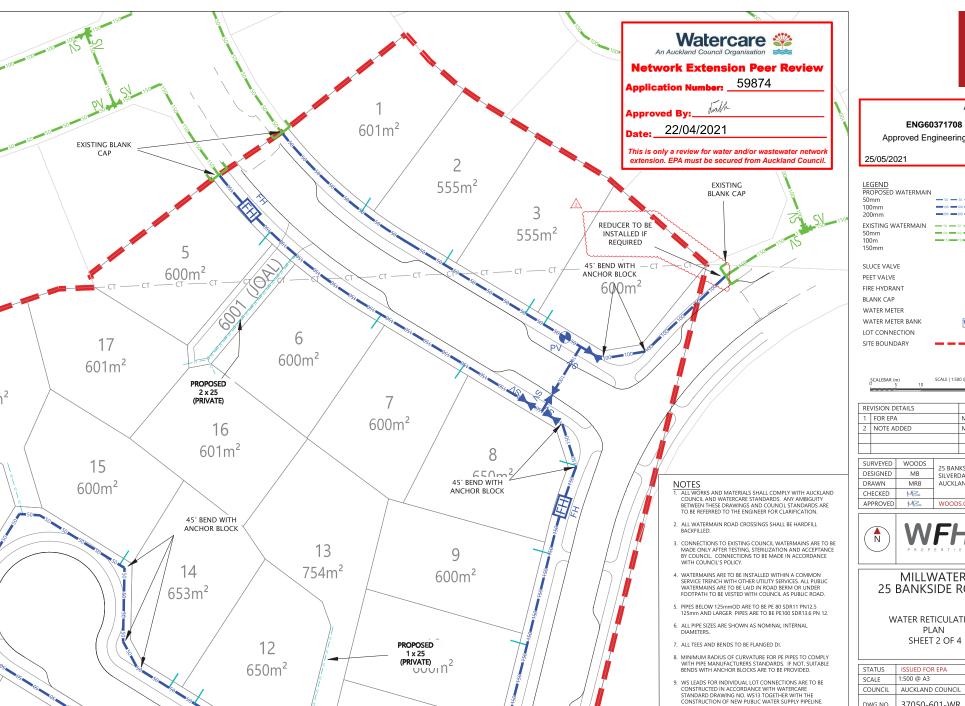



Auckland Council

Approved Engineering Plan

SCALE | 1:500 @A3 | 1:250 @A1|

SV SV

₽V

FH FH

☐ B/C (M)

WMB

RE'	VISION DETAILS	BY	DATE
1	FOR EPA	MRB	11/01/21
2	NOTE ADDED	MRB	22/04/21


	SURVEYED	WOODS	25 BANKSIDE ROAD	WATER RET		
İ	DESIGNED	MB	SILVERDALE			
	DRAWN	MRB	AUCKLAND			
	CHECKED	MB		GWI DUS		
	APPROVED	MZ	WOODS.CO.NZ] 3		





MILLWATER 25 BANKSIDE ROAD

WATER RETICULATION SHEET 2 OF 4

STATUS	ISSUED FOR EPA	REV	C/12DS			
SCALE	1:500 @ A3	2	ξ ģ			
COUNCIL	AUCKLAND COUNCIL	~	au t			
DWG NO	37050-601-WR		Docum			

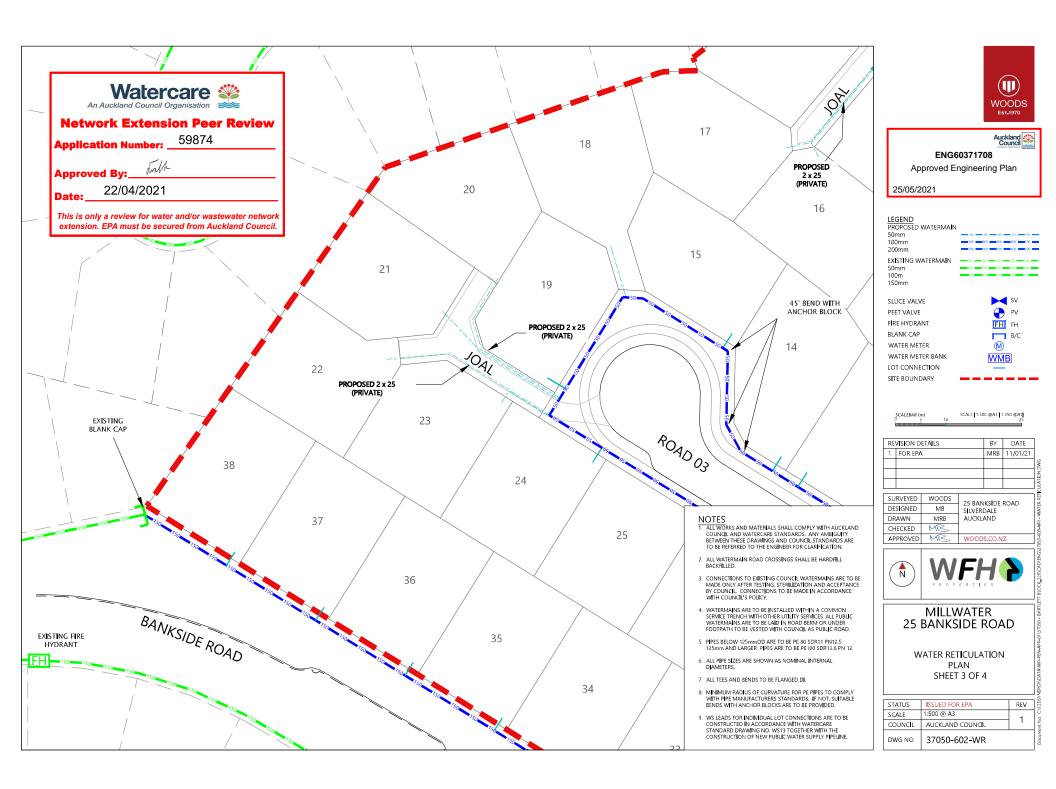

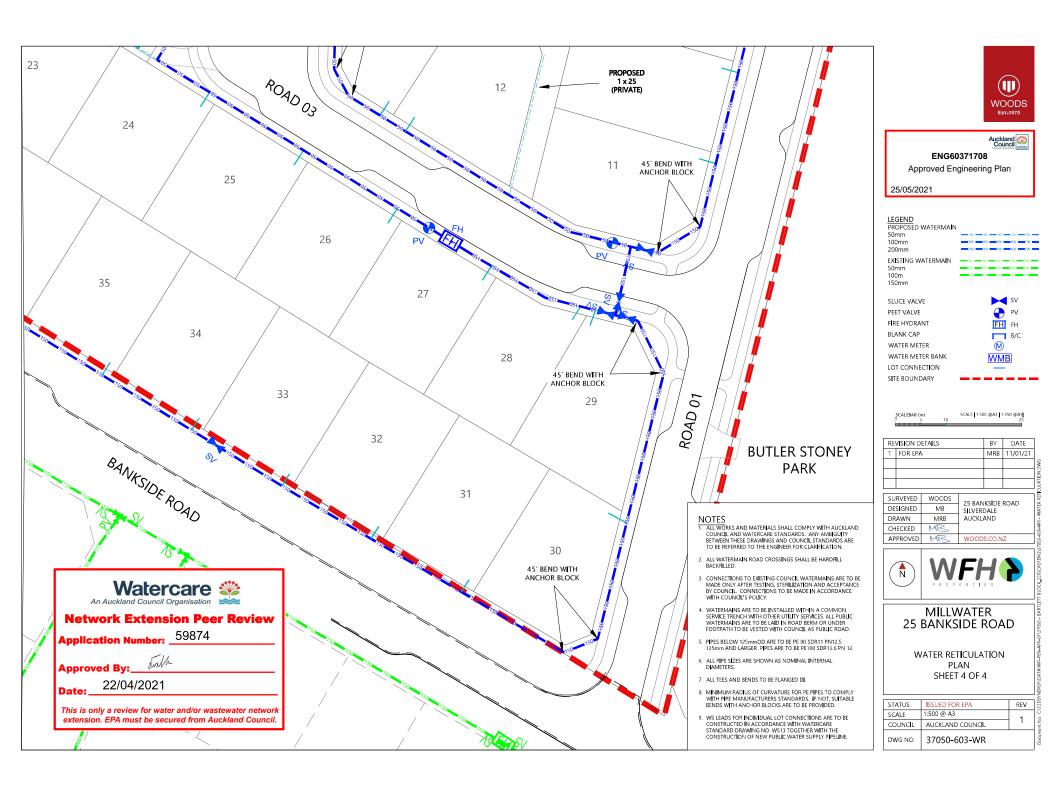

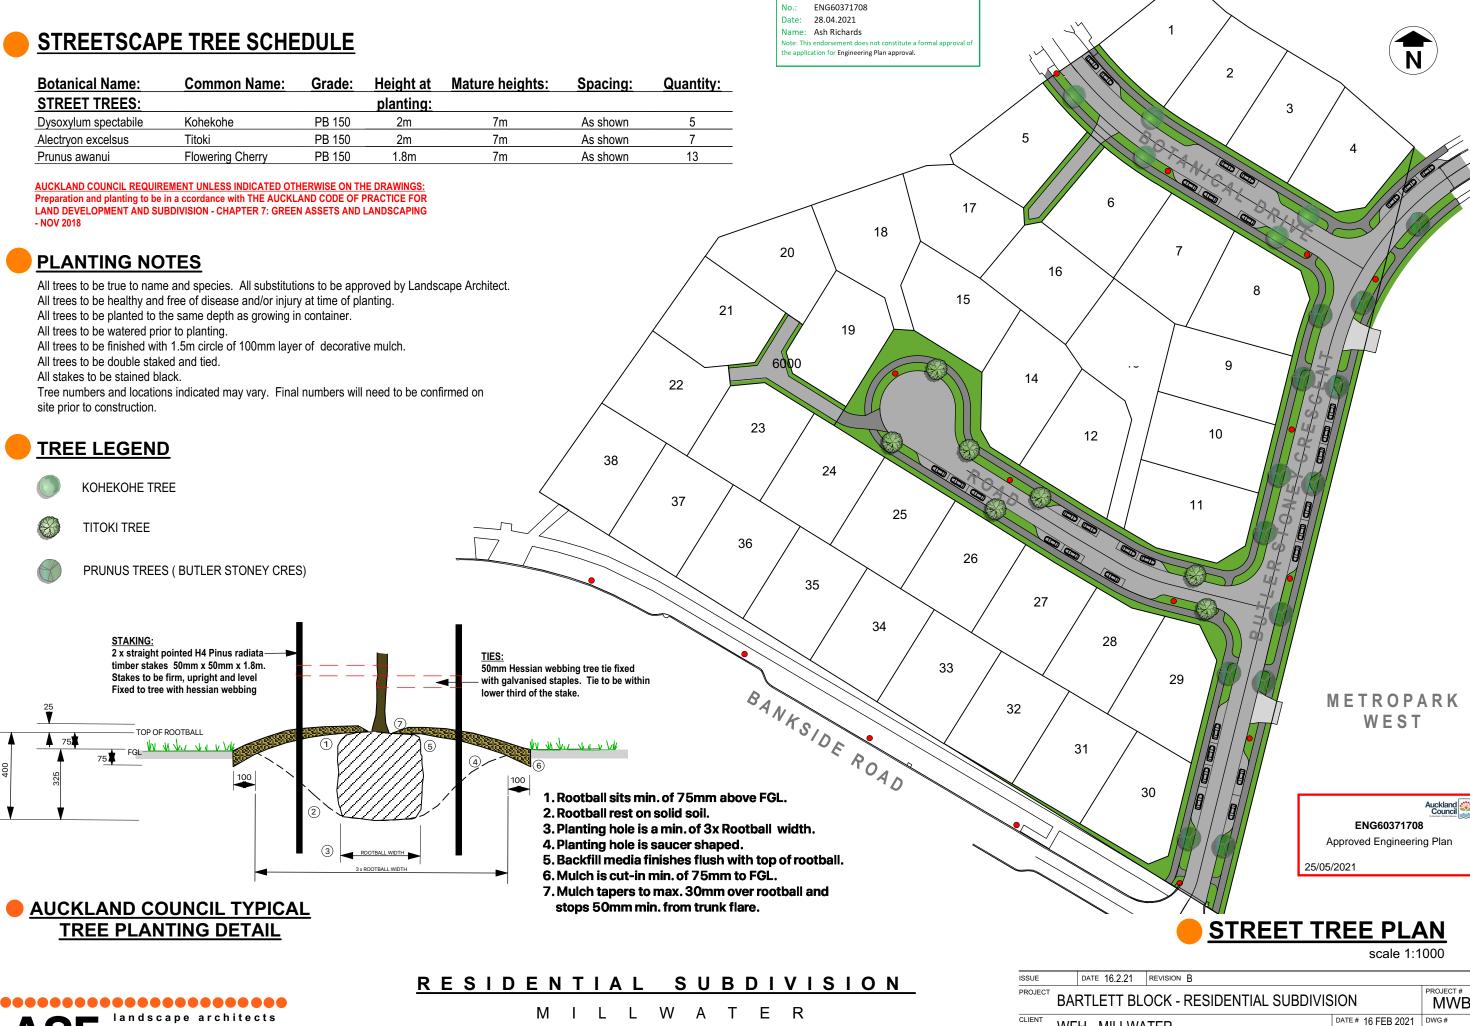

Parks Planning Endorsement

po box 60-164 auckland phone 09 8176252 n z

STREET TREE PLAN

ISSUE		DATE 16.2.21	REVISION B				
PROJECT	BARTLETT BLOCK - RESIDENTIAL SUBDIVISION PROJECT # MWB						
CLIENT	۱۸/۵	WFH - MILLWATER				EB 2021	DWG#
	VVI	VVFTI - IVIILLVVA I EN			SCALE @ A3	1:1000	001
DWG	QT	STREET TREE PLAN			DRAWN	SJF	
	ا ک				CHKD	MC	DEVISION D